



SURFACE WATER DRAINAGE PHASE 1

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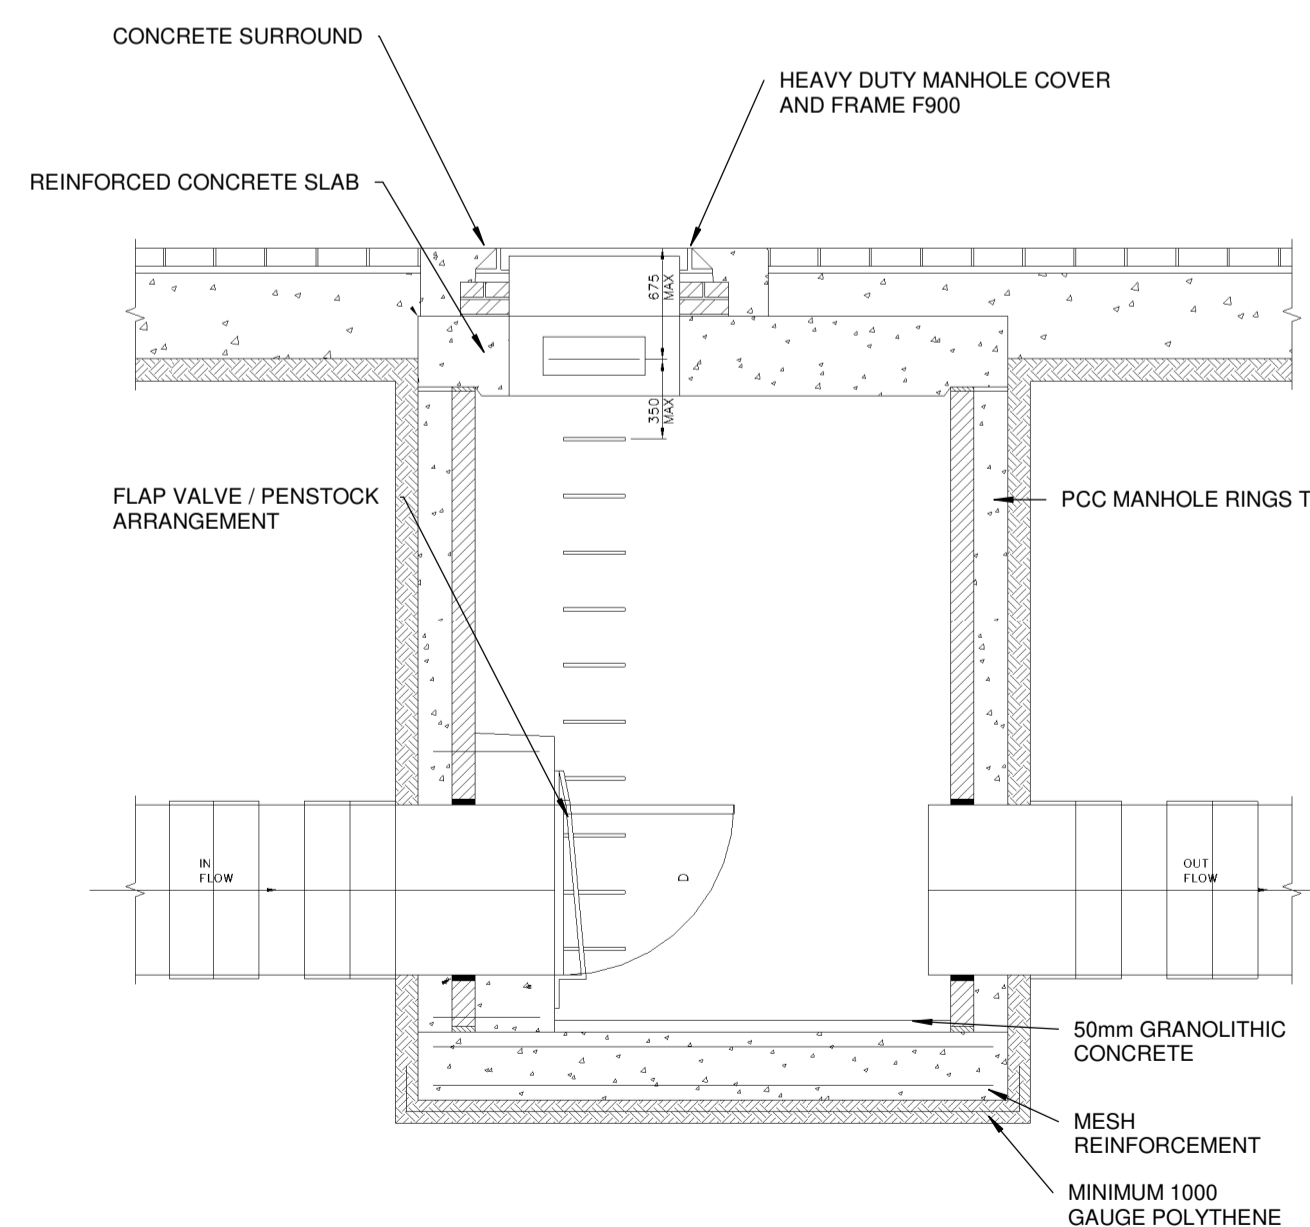


SURFACE WATER DRAINAGE PHASE 2


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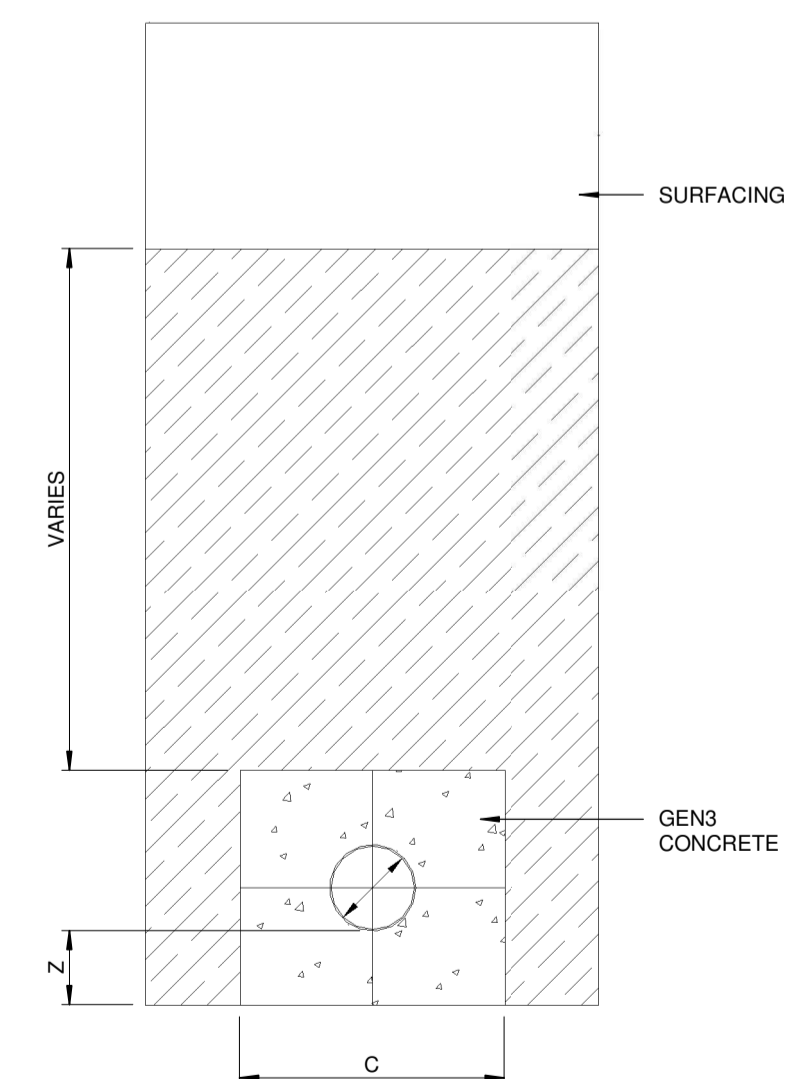
DETAIL 1 - INDICATIVE SECTION THROUGH MANHOLE
SCALE 1:25

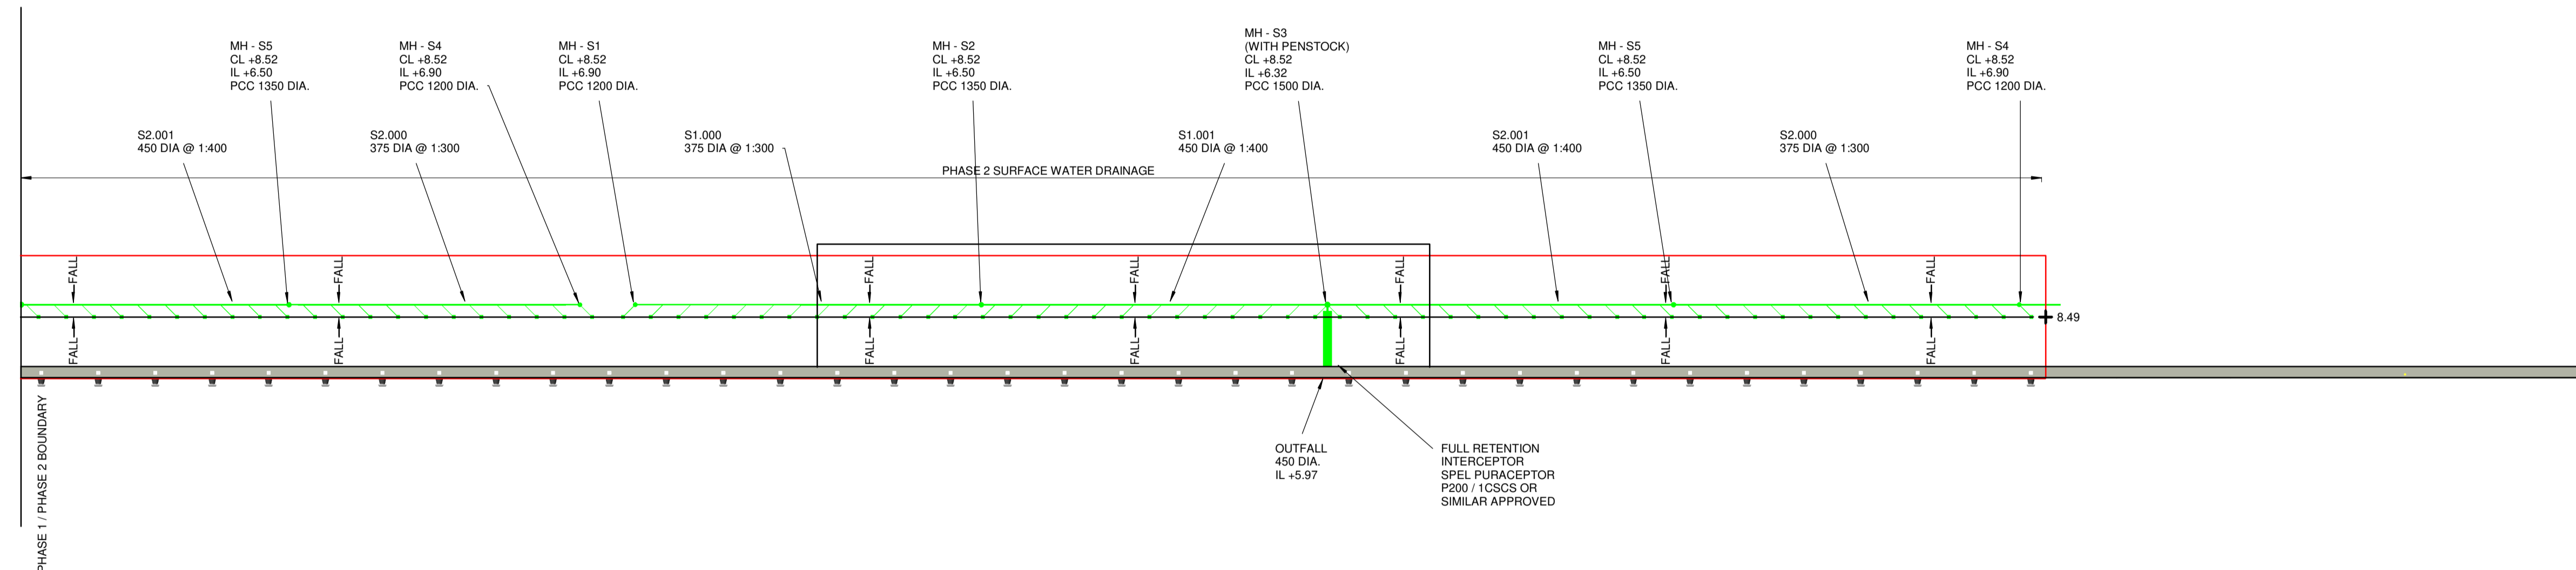

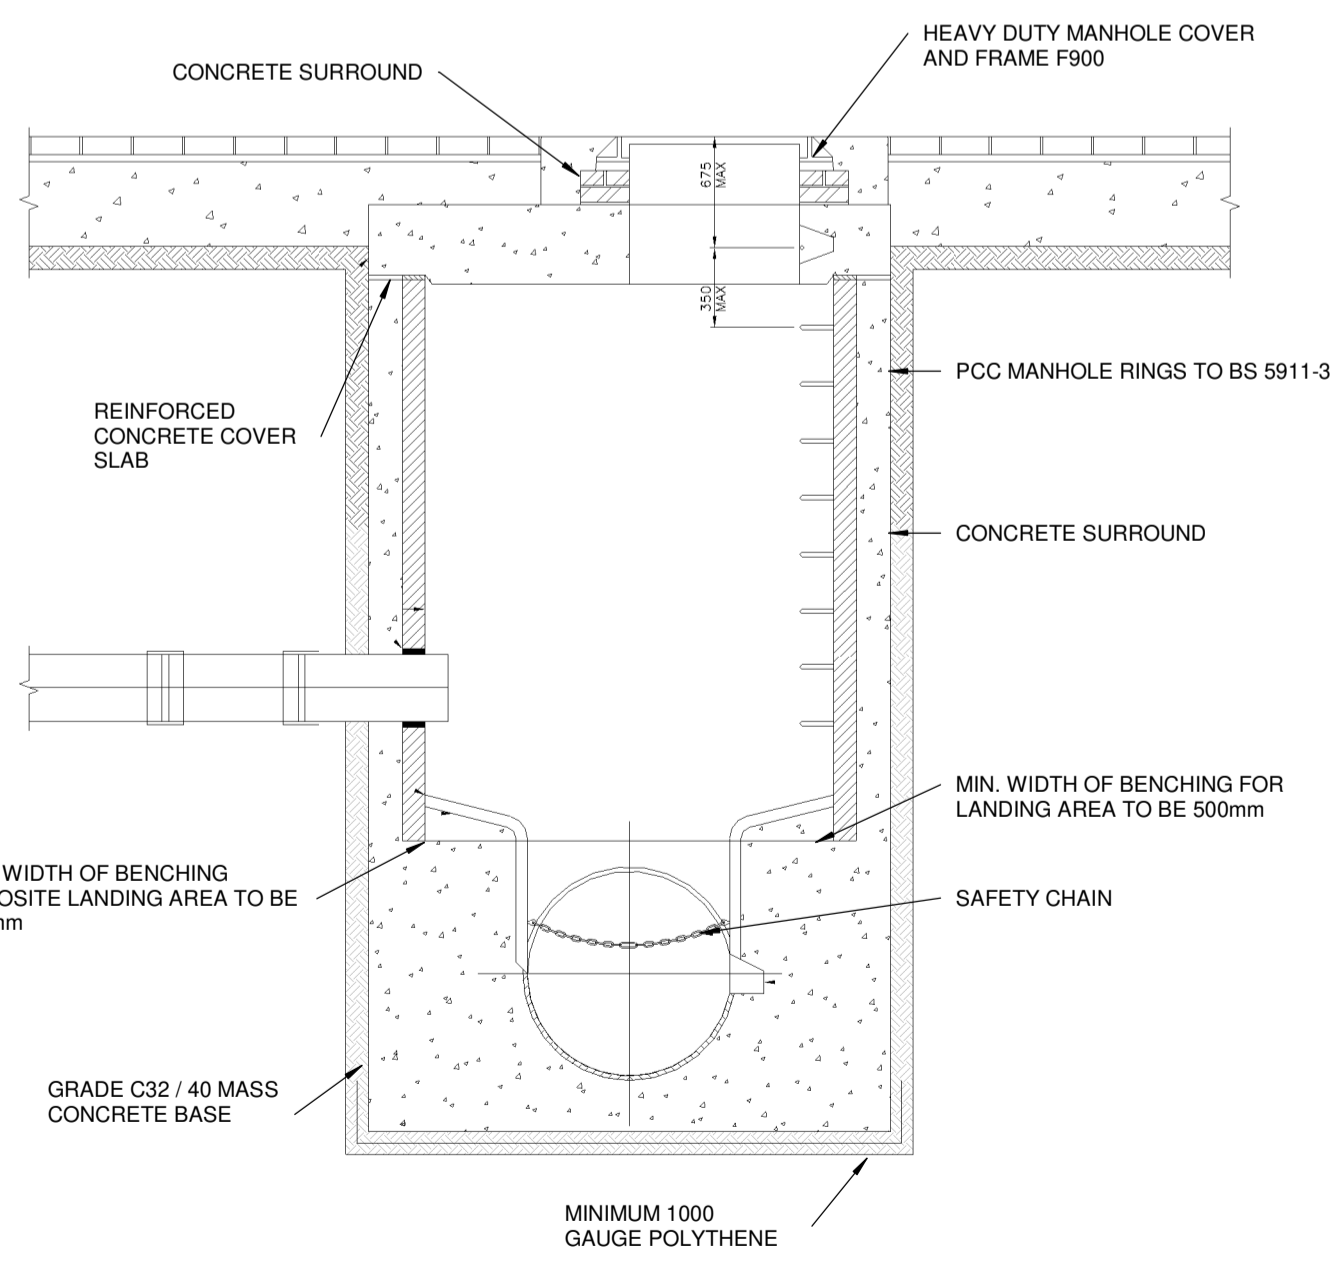DETAIL 2 - INDICATIVE SECTION THROUGH MANHOLE WITH PENSTOCK
SCALE 1:25



DETAIL 3 - INDICATIVE SECTION THROUGH GULLY
SCALE 1:20

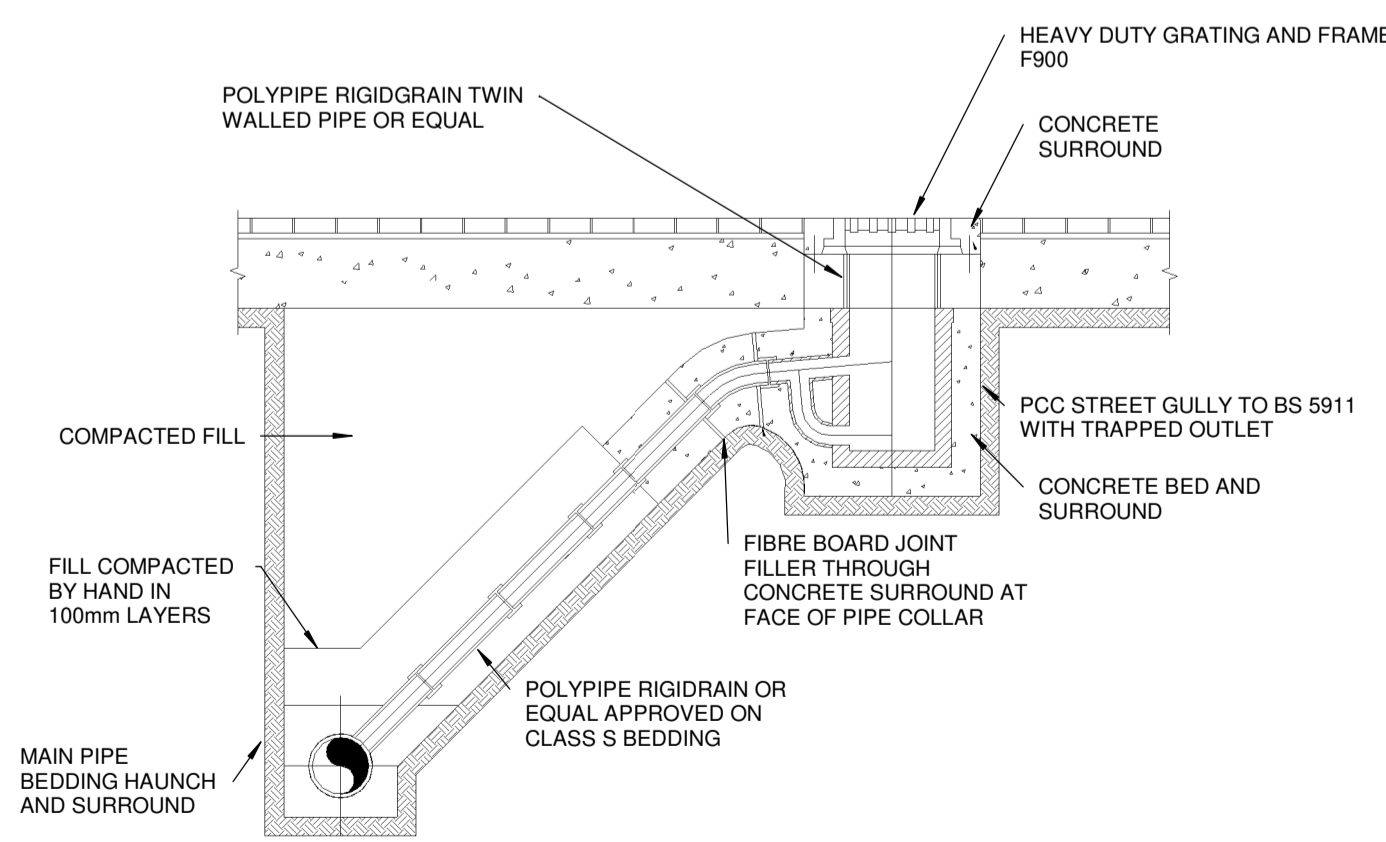

DETAIL 4 - INDICATIVE SECTION THROUGH BURIED PIPE
SCALE 1:20

NOTES

1. ALL DIMENSIONS ARE IN MILLIMETRES UNLESS NOTED OTHERWISE
2. ALL LEVELS ARE IN METRES RELATIVE TO CHART DATUM (MCD) UNLESS NOTED OTHERWISE
3. MANHOLE, GULLY FRAMES AND COVERS TO BE MIN CLASS F900
4. INTERCEPTOR TO BE SURROUNDED BY CONCRETE PROTECTION STRUCTURE SUITABLE FOR AREA LOADS

KEY:

- PRECAST MANHOLE
- GULLY
- SURFACE DRAINAGE AREA

P01	24.08.20	FOR REVIEW AND COMMENT	CH	CF	TJR
REV	DATE	DESCRIPTION	DRW	CHK	APR

REVISIONS

CLIENT



PROJECT

TEES STUDY

TITLE

CONCEPT DESIGN SURFACE WATER DRAINAGE LAYOUT AND TYPICAL DETAILS



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DRAWN	CH	CHECKED	CF	APPROVED	TJR
DATE	24/08/20	SCALE	As indicated	REF.	

DRAWING No.	PC1084-RHD-SB-DN-DR-C-1385	SUITABILITY	S3	REVISION	P01
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